

Drawing number / Rev
B1297000-PH2/3000.01a/0004 C4


FOR CONTINUATION,
SEE DRAWING NO. 0005

NOTES

- All dimensions in metres unless otherwise stated.
- For complete fencing key, refer to fencing drawings.

KEY

- High Forest - Dry (Planting at 2m centres, random mix in groups of 3-5 of each species) (LE2.1 and LE2.4.1)
- High Forest - Dry (Planting at 2.5m centres, random mix in groups of 3-5 of each species) (LE2.1 and LE2.4.1)
- High Forest - Wet (Planting at 2m centres, random mix in groups of 3-5 of each species) (LE2.1 and LE2.4.1)
- High Forest - Wet (Planting at 2.5m centres, random mix in groups of 3-5 of each species) (LE2.1 and LE2.4.1)
- Dry Woodland Edge (2m wide, planting at approximately 1.2 - 1.5m centres in three staggered rows, random mix of 3-5 species (LE2.1 and LE2.4.1) Care must be taken not to plant in oblique or straight lines. Refer to plant spacing detail on drawing B1297000/3000.01a/0001
- Wet Woodland Edge (2m wide, planting at approximately 1.2 - 1.5m centres in three staggered rows, random mix of 3-5 species (LE2.1 and LE2.4.1) Care must be taken not to plant in oblique or straight lines. Refer to plant spacing detail on drawing B1297000/3000.01a/0001
- Scrub random mix in groups of 3-5 of each species (LE2.2)
- Wetland Scrub random mix in groups of 3-5 of each species (LE2.2)
- Existing Woodland to be managed (LE2.1.1)
- Existing Woodland Edge to be Managed (LE2.2)
- Scattered Trees in Wet Grassland, Marsh and Fen (LE2.4.1) Refer to plant spacing detail on drawing B1297000/3000.01a/0001
- Scattered Scrub in Neutral Grassland (LE2.1.3.1) Refer to plant spacing detail on drawing B1297000/3000.01a/0001
- Climbing plants on fences and structures - 4m linear spacing unless otherwise noted.
- Woodland/woodland edge infill planting
- Amenity Tree and Shrub Planting (LE2.1)
- Extra large standard, semi-mature tree or multi-stem tree
- Site of Special Scientific Interest (SSSI)
- Site of Nature Conservation Importance (SNCI)
- Native Species Hedgerows (LE4.3) Two staggered rows, planted at 0.5m centres, 0.5m between rows. Trees shall be planted in between rows at an average of 10m - 15m centres. Each tree shall be marked/identified with a pole as described in Appendix 30.6.1 Planting, siting and substitution in Revision 9 (or later) of the Scheme S300 Appendices.
- Ditch
- Watercourse
- Pond
- Public Footpath
- Byway
- Bridleway
- Existing trees, hedges & scrub to be retained
- Woodland management zones
- CPD boundary
- Steep slopes reinforced with soil nailing and hydroseeded with grass

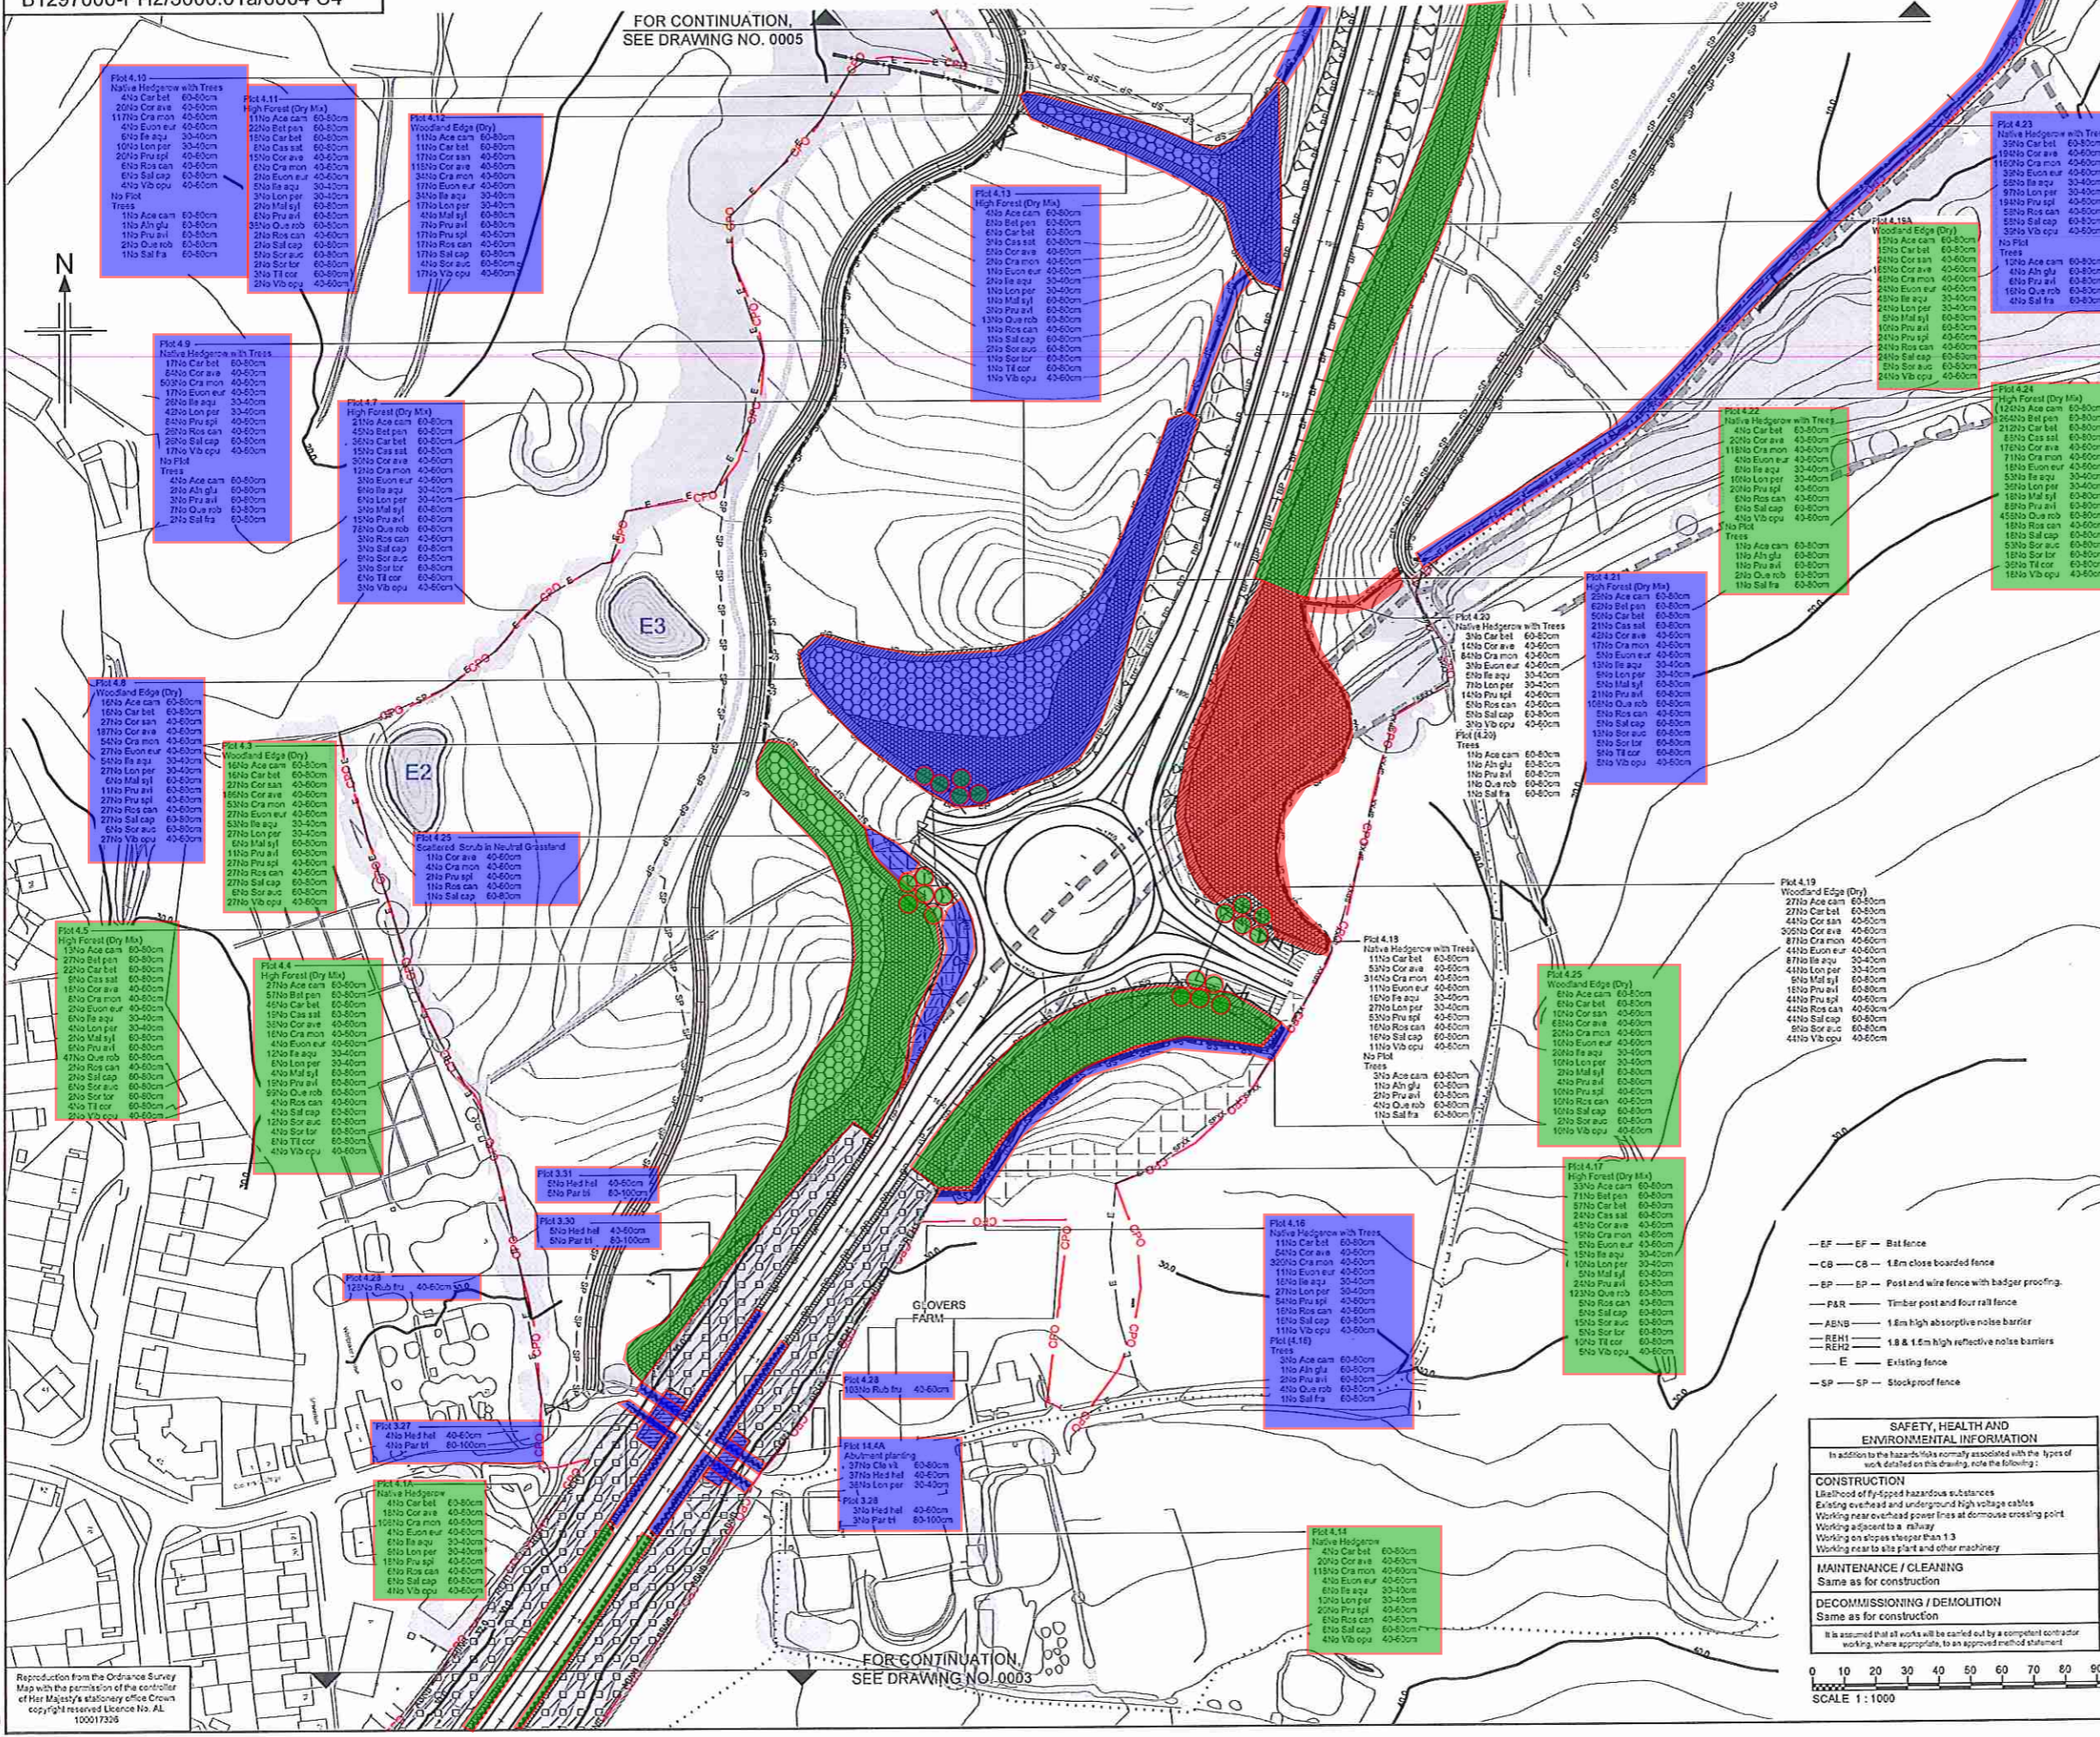

Planting to be completed

Rev	Rev. Date	Purpose of revision	Drawn	Checked	Rev'd	Apprv'd
C4	15/12/2015	Minor Planting Changes	LC	AS	AS	PDF
C3	04/11/2015	Planting revs to match scheme changes	AS	RM	RM	PDF
C2	11/05/2015	Plant Schedule Updated to Match Changes	CG	AS	TD	JP
C1	02/03/2015	NEBRG Roundabout Added	AS	FM	AS	JP
C0	26/07/2013	ISSUED FOR CONSTRUCTION	AS	FM	AS	JP

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Client: HOCHTIEF
Employer: TAYLOR WOODROW

Project: BEXHILL TO HASTINGS LINK ROAD

Drawing title: PLANTING SHEET 4 OF 14

Drawing status: FOR CONSTRUCTION

Scale: 1:1000 @ A1 DO NOT SCALE

Jacobs No. B1297000

Client No.

Drawing number: B1297000-PH2/3000.01a/0004 Rev C4

SAFETY, HEALTH AND ENVIRONMENTAL INFORMATION

In addition to the hazards/risks normally associated with the types of work detailed on this drawing, note the following:

CONSTRUCTION

- Likelihood of fly-spiced hazardous substances
- Existing overhead and underground high voltage cables
- Working near overhead power lines at domestic crossing point
- Working adjacent to a railway
- Working on slopes steeper than 1:3
- Working near to site plant and other machinery

MAINTENANCE / CLEANING

Same as for construction

DECOMMISSIONING / DEMOLITION

Same as for construction

It is assumed that all work will be carried out by a competent contractor working, where appropriate, to an approved method statement.

- BF—BF— Bat fence
- CB—CB— 1.8m close boarded fence
- EP—EP— Post and wire fence with badger proofing
- FAR—FAR— Timber post and four rail fence
- ABNB— 1.8m high absorptive noise barrier
- REH1— 1.8 & 1.6m high reflective noise barriers
- E—E— Existing fence
- SP—SP— Stockproof fence



FOR CONTINUATION,
SEE DRAWING NO. 0005

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11 JAN 2016
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